

DETAILED DESIGN FOR PROPOSED ADMINISTRATION OFFICES IN NORTH GALKAIO DISTRICT, MUDUG REGION

PROJECT:

Detailed Design For Proposed Administration Offices In North Galkaio District, Mudug Region





THE FEDERAL REPUBLIC OF SOMALIA

GOVERNMENT OF PUNTLAND STATE - GALKAIYO NORTH DISTRICT

FINANCED BY:



IMPLEMENTED BY:



CONSULTANT:



#### ECOTECH LIMITED

P.O. Box 5527-00100, Nairobi - Kenya

Tel: +254 712 388815 Fax: +254 20 250809 Email: Info@ecotech.co.ke

Location: Ecotech House, Woodlands Road, off Lenana Road, Nairobi - Kenya







SIGNED & STAMPED:

Almed Linish


## DETAILED DESIGN FOR PROPOSED ADMINISTRATION OFFICES IN NORTH GALKAIO DISTRICT, MUDUG REGION

CONTRACT No. MOF/SFF/SERV/08

SFF-LD GRANT Nº: TF0A1715

#### JULY 2017 DRAWING INDEX

	SHEET Nº	DRAWING Nº	DRAWING CONTENT
01.	01/19	31371-553-SITE ANALYSIS-01	Site Analysis
02.	02/19	31371-553-SITE PHOTOS-02	Site Photos
03.	03/19	31371-553-MASTERPLAN-03	Masterplan
04.	04/19	31371-553-FLOORPLAN-04	Floorplan Layout
05.	05/19	31371-553-ELEVATIONS 01-05	Elevations 01
06.	06/19	31371-553-ELEVATIONS 02-06	Elevations 02
07.	07/19	31371-553-SECTIONS-07	Sections
08.	08/19	31371-553-ROOF PLAN-08	Roof Plan
09.	09/19	31371-553-STRUCTURAL 01-09	Structural Details 01
10.	10/19	31371-553-STRUCTURAL 02-10	Structural Details 02
11.	11/19	31371-553-STRUCTURAL 03-11	Structural Details 03
12.	12/19	31371-553-STRUCTURAL 04-12	Structural Details 04
13.	13/19	31371-553-GATE HOUSE-13	Gate House
14.	14/19	31371-553-GATE & BWALL-14	Gate and Boundary Wall
15.	15/19	31371-553-GH STRUCTURAL-15	Gate House Structural Details
16.	16/19	31371-553-SEPTIC TANK-16	Septic Tank Details
17.	17/19	31371-553-ELECTRICAL-17	Electrical Layout
18.	18/19	31371-553-PLUMBING-18	Plumbing Layout
19.	19/19	31371-553-PERSPECTIVES-19	3D rendering views

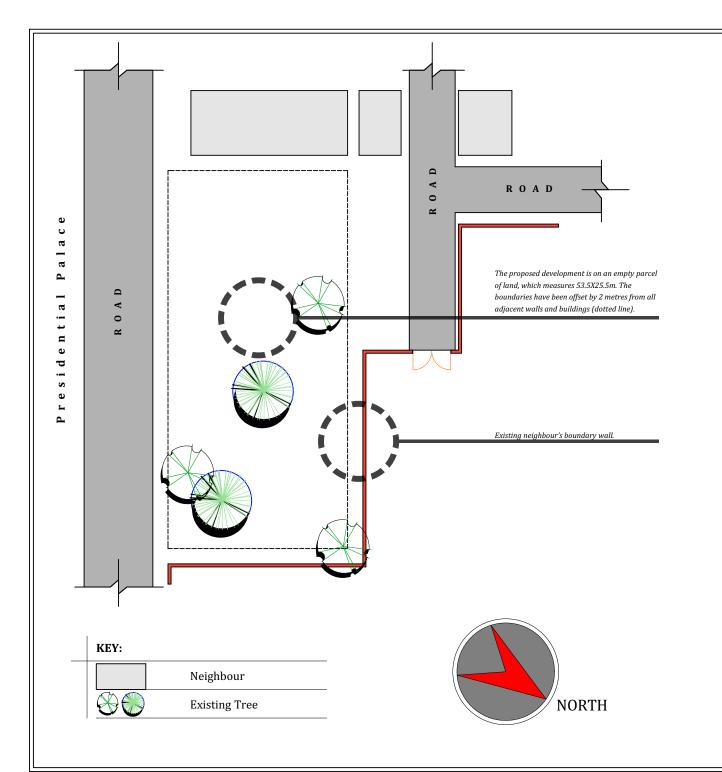

#### SITE PHOTOS



There is a neighbour's boundary wall (beyond) on two edges, fully on one edge, partially on the other.



A view of the presidential palace (white wall beyond) and street oriented Northeast and Southwest.



The site will be fenced off and cleared of debris.



A new boundary wall shall be built with an offset of 2m from the neiahbour's wall.



View of road headed Northwest.



A view of the neighbouring wall and road headed Northwest.



A view of the adjacent structures.



Some trees may be eliminated but there shall be landscaping (tree planting) in the new development.



View of existing neighbour's structure (Northeast).



View of neighbour on Southwest.

#### NOTE

This drawing is protected under the copyright cannot be reused or reproduced in part or in w

mited
All dimensions are to be checked on site. An
screpancy in dimensions is to be reported to the
totech architect before any work commence. The

All construction work to comply with t

The PV denotes permanent ventilation and must be led above all doors and windows where indicated.

All reinforced concrete works to be done according to

NO:	DATE:	DESCRIPTION:			
REVISIONS.					







EMENTED BY:



CONSULTANT:



#### ECOTECH LIMITED

D. Box 5527-00100,

+254 712 388815 +254 701 838222 Info@cotech.co.ke www.cotech.co.ke

roject Title:

DETAILED DESIGN FOR PROPOSED

ADMINISTRATION OFFICES IN

NORTH GALKAIO DISTRICT,

MUDUG REGION

awing Title:

SITE ANALYSIS

SETTE ANALYSIS

AS SHOWN

Date: JULY 2017
PREPARED BY: PETER MUTUGI

REVIEWED & APPROVED BY:

HMED KIRISH ENG. ALI HUS

Drawing No: Project No:
31371-553SITE ANALYSIS-01 MOF/SFF/SERV/OS
Sitect No:



There are several mature trees on the site.



View of neighbouring structures on the Southwest, and secondary access road headed Northwest.



View towards the East of the site.





View towards the presidential palace.



View of adjacent business.



View towards the East of the site.



View towards the South of the site.



View of adjacent building.



View of adjacent buildings.



Consultations held with PIU and government officials.



Consultations held with PIU and government officials.









NO:	DATE:	DESCRIPTION:	٦			
	DEVISIONS					













SITE PHOTOS


JULY 2017 PETER MUTUGI


31371-553-SITE PHOTOS-02

MOF/SFF/SERV/08

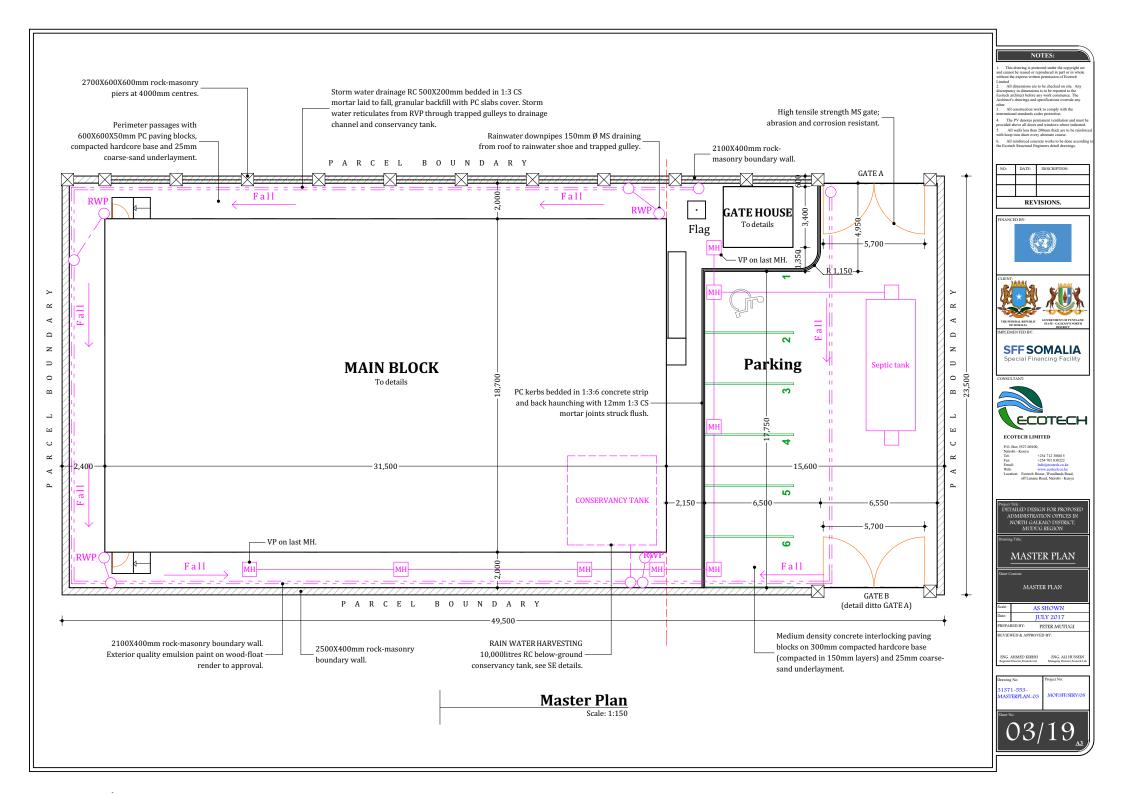

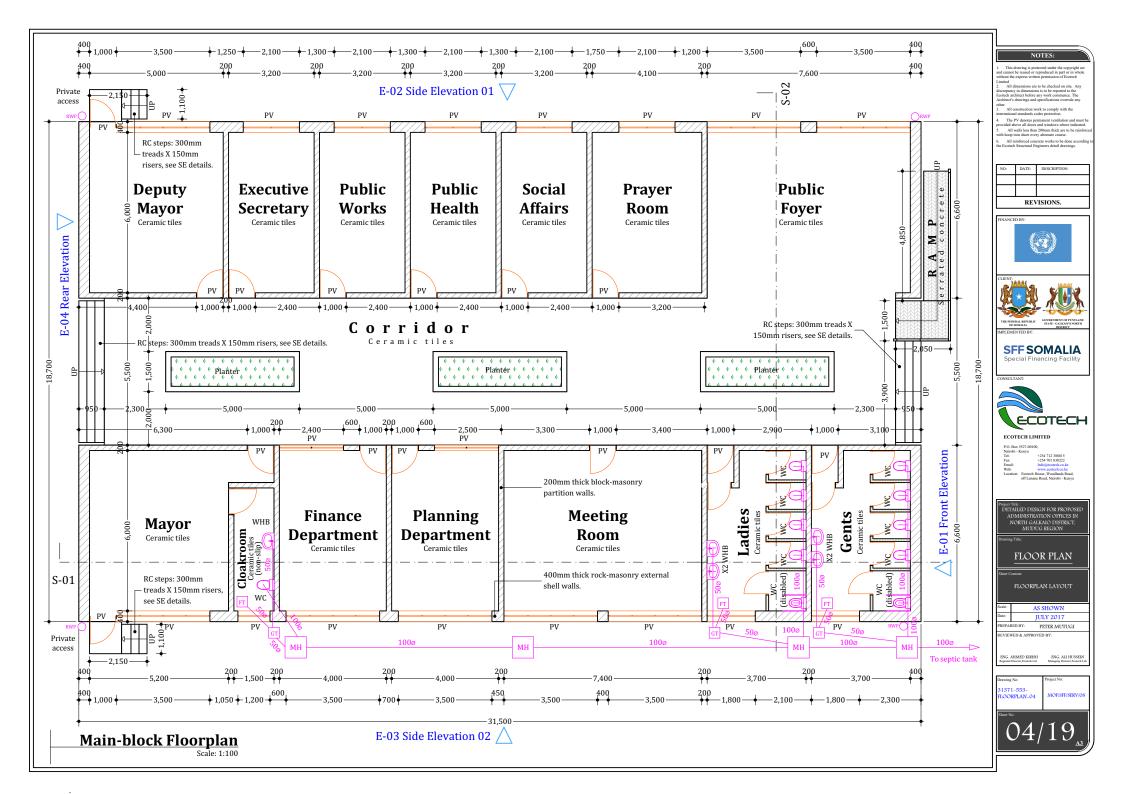

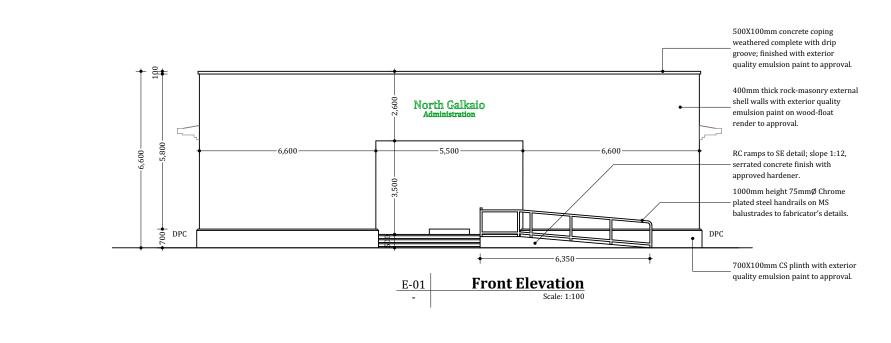

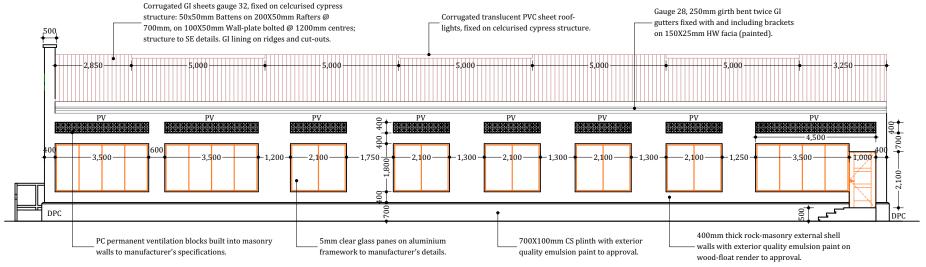

E-02 Side Elevation 01
Scale: 1:100

NOTE

 This drawing is protected under the copyrigl and cannot be reused or reproduced in part or in w

 All dimensions are to be checked on site discrepancy in dimensions is to be reported to Ecotech architect before any work commence.

other.

The PV denotes permanent ventilation and must

vided above all doors and windows where indicated All walls less than 200mm thick are to be reinfo

6. All reinforced concrete works to be done according

NO: DATE DESCRIPTION:

REVISIONS.







EMENTED BY:

SFF SOMALIA
Special Financing Facility

CONSULTANT:



ECOTECH LIMITED

Box 5527-00100, obi - Kenya

Kenya +254 712 388815 +254 701 838222 Info@ecotech.co.ke www.ecotech.co.ke

isst Title :
DETAILED DESIGN FOR PROPOSED
ADMINISTRATION OFFICES IN
NORTH GALKANO DISTRICT,
MUDUG REGION

Drawing Title:

ELEVATIONS 01

ELEVATIONS 01


AS SHOWN
te: JULY 2017


EPARED BY: PETER MUTUGI

REVIEWED & APPROVED BY:

HMED KIRISH ENG. ALI HUS Necctor, Ecotoch Ltd. Managing Director, Eco

Drawing No: Project No: 31371–553- ELEVATIONS 01–05 MOF/SFF/SERV/O: Sheet No:

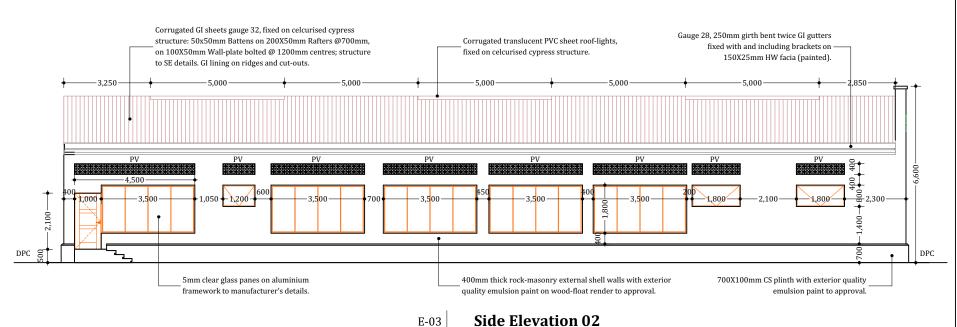

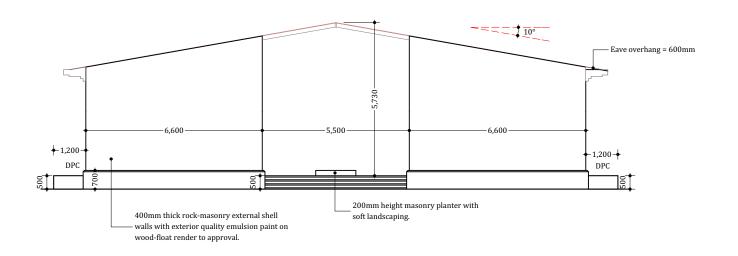

E-04

**Rear Elevation** 

#### NOTES:

mited

All dimensions are to be checked on site. Any screpancy in dimensions is to be reported to the coech architect before any work commence. The rehitect's drawings and specifications overrule any

The PV denotes permanent ventilation and must be ovided above all doors and windows where indicated. All walls less than 200mm thick are to be reinfore the hoop iron sheet every alternate course.

П			/ICIONC
П			
Ш			
Ш	NO:	DATE:	DESCRIPTION:







**SFF SOMALIA** 



#### ECOTECH LIMITED

roject Title:

DETAILED DESIGN FOR PROPOSED

ADMINISTRATION OFFICES IN


NORTH GALKAIO DISTRICT,

MUDUG REGION

#### **ELEVATIONS 02**

JULY 2017 PREPARED BY: PETER MUTUGI

31371-553-ELEVATIONS 02-06 MOF/SFF/SERV/08

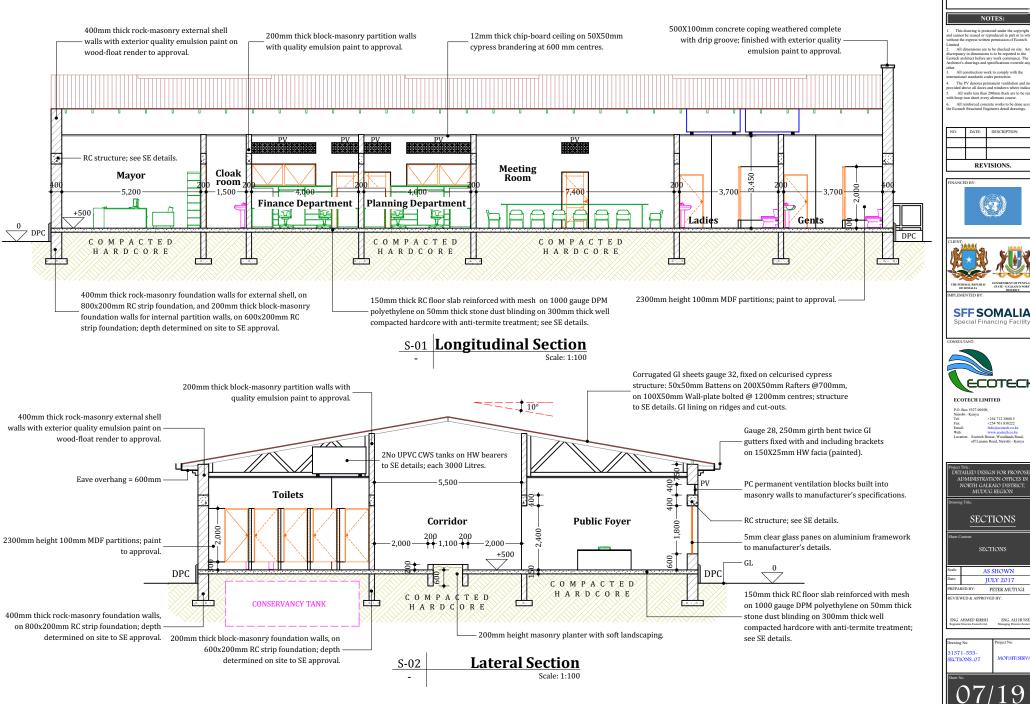

I	NO:	DATE:	DESCRIPTION:	
I				
ı				
П		REV	ISIONS.	





**SFF SOMALIA** 






SECTIONS

JULY 2017

PETER MUTUGI

ENG. ALI HUSSEII

MOF/SFF/SFRV/O

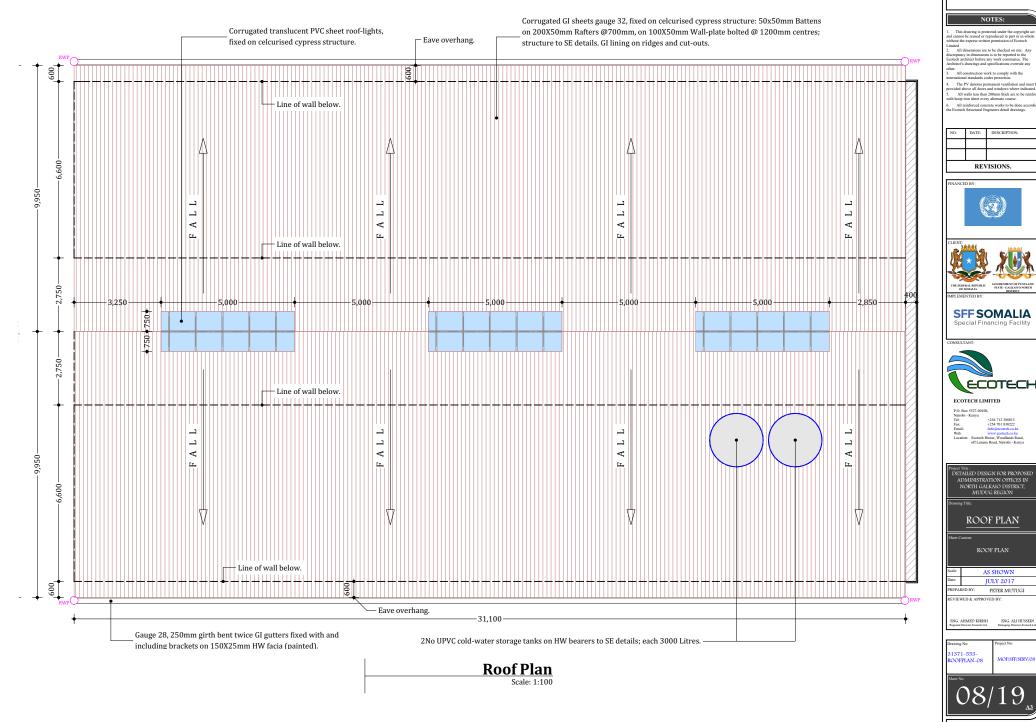

NO:	DATE:	DESCRIPTION:
-	+	



**SFF SOMALIA** 



roject Title:

DETAILED DESIGN FOR PROPOSED

ADMINISTRATION OFFICES IN

NORTH GALKAIO DISTRICT,

MUDUG REGION


ROOF PLAN

JULY 2017

PETER MUTUGI

ENG. ALI HUSSEIN Managing Director Leonech I

MOF/SFF/SERV/O

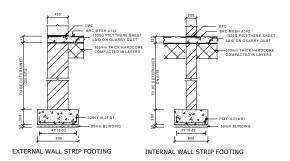






200X300 TYPICAL RING BEAM



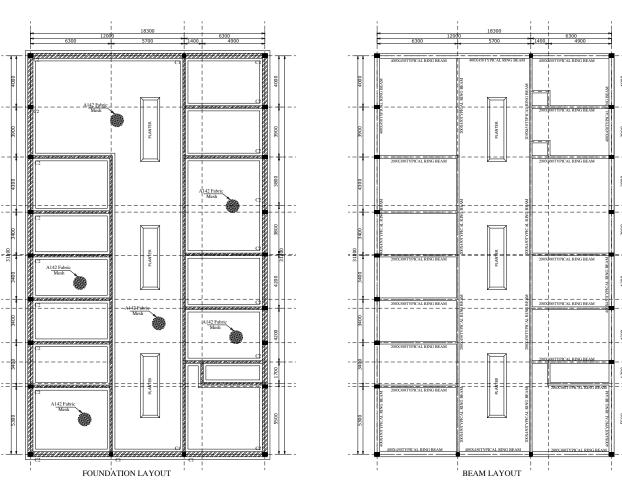

#### NOTES ON STRUCTURAL DETAILS

- These notes shall be deemed to apply to all structural drawings.
- The structural drawings shall be read in conjunction with the architectural drawings and in event of any discrepancies, the Engineer and the Architect shall be notified before proceeding with the work.
- All dimensions shall be verified by the Contractor and drawings shall not be scaled off.
- Concrete shall have 20mm maximum size of aggregates and shall be adequately vibrated and cured. Concrete grade shall be Class 25 unless otherwise stated by the Engineer.
- 5. Building concrete shall be 1:4:8 mix and shall be 50mm thick unless otherwise stated.
- 6. Building blocks shall be adequately bonded and set in 3:1 sand/cement mortar.
- Steel reinforcement shall be cold worked bars to B.S. 4461 ref. Y and Round Mild Bars to B.S. 4448 ref. R.
- 8. Unless otherwise stated, concrete covers shall be:
  - 50mm for foundations.
  - 40mm for columns
  - 20mm for slabs and staircases
  - 25mm for beams
- Contractor shall verify the dimensions given in the Bending Schedules before cutting and bending steel reinforcement.
- 10. These notes do not supersede the Specifications and the Contractor shall consult the Engineer in event of any contradictions.
- Cube Tests shall be done for every concreting. Any
  concrete work that fails tests shall be demolished
  and redone at the cost of the Contractor.
- 12. Safe bearing pressure of soil is 150KN/m<sup>2</sup>
- Structural timber shall be well-seasoned timber stress grade S3 cypress (B.S. 5268-2:2002) with min. moisture content of 12%.

MEMBER	No	BARS PER	DIA.	LENGTH	TOTAL NUM-	MARK	s c		B E	NDIN	G	
	OF	мемв			BER			A	В	С	D	E/r
COL C1  COL C2  B WALL	16	4 2 4 2 25 4 4 3	Y16 Y12 Y16 Y16 Y8 Y12 Y12 Y12 Y12	2450 2450 4075 4075 1025 2225 5175 3500	64 32 400 76 76	01 01a 02 02a 03 01 02 02	37 37 42 42 61 37 42 20	2330 2330 900 900 330 2130 700 (3500)	(150) (150) 250 250 130 (130) 200	2810 2810 4160	51 51 47	
FOOTING GATE HSE SLAB RAMP	1	15 13 10 10 25 6 6 6 6 8 9 9 20 20 20 20 20 20	Y10 Y10 Y8 Y8 Y10 Y10 Y10 Y10 Y10 Y10 Y10 Y12 Y12 Y12 Y12 Y12 Y12 Y12	5775 6475 1600 1900 2375 3375 5150 5150 2350 1250 1250 1250 1250 1250 1625 1625 1775	13 10 10 25 6 6 6 6 8 9 9 20 20 20 20	C D E	55 55 20 20 61 61 20 20 38 38 20 45 62 133 133 133	1165 1265 (1600) (1900) 1030 (5150) (5150) 1760 1360 (1250) (1250) 640 1350 540 540 540	100 100 1530 100 100 800 600 1020 1020 1160 650	(540) (440) (100) (540) (100) (100) (100)	285 240 240 240 545	(1165) (1265)
ENT STAIRS B STRIP FOOTING	25 36 712 3295	28 28 28 28 28 28 28 3 1 1	Y12 Y12 Y12 Y12 Y12 Y12 Y12 Y12 Y10 Y10 Y10	1950 37505 1525 1900 1625 1625 1777 1950 5450 4000 4000 775 925	28 28 28 28 28 28 28 8 100 108	G A B C D E F G 02 02 01a	45 62 133 133 133 45 20 20 20 35 35	1220 (3740) 640 1350 540 540 540 (5440) (4000) (4000) 730	800 600 1020 1020 1160 650	(100) (540) (100) (100) (100) (100)	285 240 240 240 545	
8	10	12	16	20 2	5 32	40	то	Т				
R Y 176 TOT 176	2956 2956	1171 1171	865 865					168 168				

#### NOTES:

 This drawing is protected under the cop and cannot be reused or reproduced in part o

2. All dimensions are to be checked on site. An discrepancy in dimensions is to be reported to the

discrepancy in dimensions is to be reported to th Ecotech architect before any work commence. T Architect's drawings and specifications overrule

- All construction work to comply with the
- The PV denotes permanent ventilation and must be ovided above all doors and windows where indicated. All walls less than 200mm thick are to be reinforce th hoop iron sheet every alternate course.
- All reinforced concrete works to be done according
  the Ecotoch Structural Engineery detail drawings

NO:	_	DATE:	DESCRIPTION:
L	4		





OFFICE STATE - GALKATION OF PUNT STATE - GAL

SFF SOMALIA Special Financing Facility



ECOTECH LIMITED

D. Box 5527-00100, irobi - Kenya

| +254 712 388815 | x: +254 701 838222 | nail: | Info@ecotech.co.ke | cation: Ecotech House, Woodlands Ron



STRUCTURAL 01

Sheet Content:
STRUCTURAL DETAILS 0

icale: AS SHOWN
Date: JULY 2017

PREPARED BY: PETER MUTUGI

G. AHMED KIRISH ENG. ALI HU

Drawing No.


31371-555STRUCTURAL 01-09

MOFISTFISERV/08


Store No.


09/19

A3

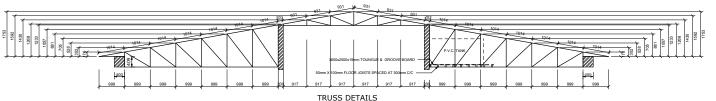

ALL MEMBERS ARE 50mmX100mm OR 2inchesX4inches

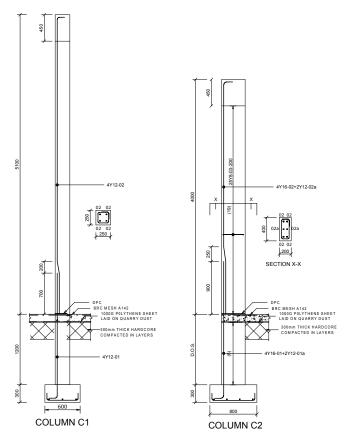

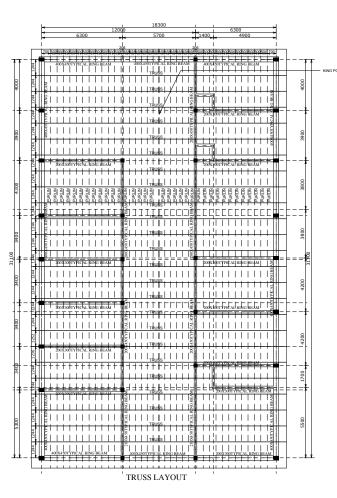

#### NOTES ON STRUCTURAL DETAILS

- These notes shall be deemed to apply to all structural drawings.
- The structural drawings shall be read in conjunction with the architectural drawings and in event of any discrepancies, the Engineer and the Architect shall be notified before proceeding with the work.
- All dimensions shall be verified by the Contractor and drawings shall not be scaled off.
- Concrete shall have 20mm maximum size of aggregates and shall be adequately vibrated and cured. Concrete grade shall be Class 25 unless otherwise stated by the Engineer.
- 5. Building concrete shall be 1:4:8 mix and shall be 50mm thick unless otherwise stated.
- Building blocks shall be adequately bonded and set in 3:1 sand/cement mortar.
- Steel reinforcement shall be cold worked bars to B.S. 4461 ref. Y and Round Mild Bars to B.S. 4448 ref. R.
- 8. Unless otherwise stated, concrete covers shall be:
  - 50mm for foundations.
  - 40mm for columns
  - 20mm for slabs and staircases
  - 25mm for beams
- Contractor shall verify the dimensions given in the Bending Schedules before cutting and bending steel reinforcement.
- 10. These notes do not supersede the Specifications and the Contractor shall consult the Engineer in event of any contradictions.
- Cube Tests shall be done for every concreting. Any
  concrete work that fails tests shall be demolished
  and redone at the cost of the Contractor.
- 12. Safe bearing pressure of soil is 150KN/m<sup>2</sup>
- Structural timber shall be well-seasoned timber stress grade S3 cypress (B.S. 5268-2:2002) with min. moisture content of 12%.

MEMBER	No	BARS PER	DIA.	LENGTH	TOTAL NUM-	MARK	s c		ВЕ	NDIN	G	
	OF	мемв			BER		-	A	В	С	D	E/r
TOP SLAB	- 1	13		3000	13		20	(3000)				
		13 13	Y10 Y10	3000 1650	13	10 12	20 38	(2994) 770	150	(770)		
		13	Y10	1650		13	38	770	150	(770)		
		14	Y10	9175	14	24	38	810	170	(8240)		
		14	Y10	9175	14	25	38	810	170	(8240)		
		14	Y10	3000	14	14	20	(3000)		,		
воттом	1	12	Y10	4800	12	03	38	750	3350	(750)		
SLAB		12	Y10 Y10	4500 1025	12	01 48	38 20	750	3050	(750)		
		3	Y10	1025	3	48	20	(1017)				
		3	Y10	1025	3	50	20	(1025)				
		3	Y10	1025	3	51	20	(1025)				
		3	Y10	1250	3	59	38	570	150	(570)		
		3	Y10	1250		58	38	570	150	(570)		
		3	Y10	1250	3	62	38	570	150	(570)		
		61 61	Y10 Y10	2600 2600	61 61	15 19	20	(2600) (2600)				
WALL 1	2	14	Y10	2450	28	16	20	(2440)				
WALL I	*	14	Y10	2050	28	20	20	(2040)				
		14	Y10	2450		17	20	(2440)				
		14	Y10	2175	28	21	20	(2160)				
		11	Y10	3250	22	26	20	(3244)				
		11	Y10	3250	22	28	20	(3244)	450	come:		
		11	Y10 Y10	1650	22	30	38	775	150 150	(775) (775)		
		14	Y10	1650		32	38	770	150	(770)		
		14	Y10	1875	28	33	45	420	560	(920)	295	
WALL 2	2	11	Y10	2550	22	38	20	(2550)		(020)		
		11	Y10	2925	22	34	20	(2920)				
		13	Y10	1875	26	22	45	420 420	560 560	(920)	295 295	
		13 13	Y10 Y10	1875 2300	26 26	23 35	45 20	(2300)	560	(920)	295	
		13	Y10	2300		39	20	(2300)				
		12	Y10	1650		36	38	770	150	(770)		
		12	Y10	1650	24	37	38	770	150	(770)		
		13	Y10	1650	26	41	38	770	150	(770)		
		13		1650	26		38	770 420	150 560	(770)	295	
		67 67	Y10 Y10	1875 1875	134 134	42 43	45 45	420 420	560 560	(920) (920)	295 295	
ENT	2	6	Y12	1525	12	A A	45	640	800	(100)	285	
STAIRS	1 -	6	Y12	1900	12	B	62	1350	600	(540)	200	
SIDES		6	Y12	1625	12	c	133	540	1020	(100)	240	
		6	Y12	1625	12		133	540	1020	(100)	240	
		6	Y12 Y12	1775 1950	12 12	E	133	540 1220	1160 650	(100)	240 545	
		8	Y12	1050	16	l G	20	(1040)	650	(100)	545	
		"		1030	"	1	1	(1040)				
	l		1				l					
8	10	12	16	20 2	5 32	40	TO	Т				
R	1509	126					Ι.	634				
	1009	126			- 1	-1	1 1	034				

#### NOTES:

This drawing is protected under the copy d cannot be reused or reproduced in part or

All dimensions are to be checked on site.
 discrepancy in dimensions is to be reported to the costech architect before any work commence.

- other.
- The PV denotes permanent ventilation and must b ovided above all doors and windows where indicated. All walls less than 200mm thick are to be reinfore th hoop iron sheet every alternate course.
- All reinforced concrete works to be done according

NO:	DATE:	DESCRIPTION:				
	REVISIONS.					





DESCRICT BY:

GOVERNMENT OF FORM
STATE - GALEARY O NOR
DISTRICT

MENTED BY:



CONSULTANT:



#### ECOTECH LIMITED

D. Box 5527-00100, irobi - Kenya

PROBLET TIME
DETAILED DESIGN FOR PROPOSED
ADMINISTRATION OFFICES IN
NORTH GALKAIO DISTRICT.
MUDUG REGION
DERMOGRAFIC
STRUCTURAL 02


ale: AS SHOWN
tte: JULY 2017

PARED BY: PETER MUTUGI

TEWED & AFFROVED BT.

awing No:
Project No:
1371-553RUCTURAL 02-10
MOF/SFF/SERV/08

10/19

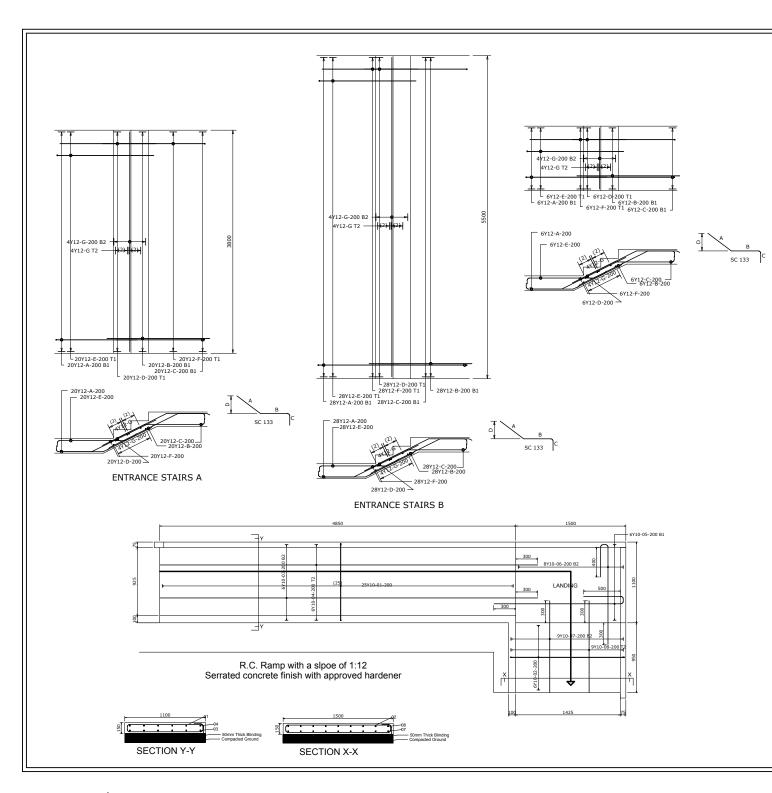

#### NOTES ON STRUCTURAL DETAILS

- These notes shall be deemed to apply to all structural drawings.
- The structural drawings shall be read in conjunction with the architectural drawings and in event of any discrepancies, the Engineer and the Architect shall be notified before proceeding with the work.
- All dimensions shall be verified by the Contractor and drawings shall not be scaled off.
- Concrete shall have 20mm maximum size of aggregates and shall be adequately vibrated and cured. Concrete grade shall be Class 25 unless otherwise stated by the Engineer.
- Building concrete shall be 1:4:8 mix and shall be 50mm thick unless otherwise stated.
- 6. Building blocks shall be adequately bonded and set in 3:1 sand/cement mortar.
- Steel reinforcement shall be cold worked bars to B.S. 4461 ref. Y and Round Mild Bars to B.S. 4448 ref. R.
- 8. Unless otherwise stated, concrete covers shall be:
  - 50mm for foundations.
  - 40mm for columns
  - 20mm for slabs and staircases
  - 25mm for beams
- Contractor shall verify the dimensions given in the Bending Schedules before cutting and bending steel reinforcement.
- 10. These notes do not supersede the Specifications and the Contractor shall consult the Engineer in event of any contradictions.
- Cube Tests shall be done for every concreting. Any
  concrete work that fails tests shall be demolished
  and redone at the cost of the Contractor.
- 12. Safe bearing pressure of soil is 150KN/m<sup>2</sup>
- $13. \ \ \, Structural timber shall be well-seasoned timber stress grade S3 cypress (B.S. 5268-2:2002) with \\ min. moisture content of 12\%.$

#### NOTE

 This drawing is protected under the copyright and cannot be reused or reproduced in part or in w

 All dimensions are to be checked on site. discrepancy in dimensions is to be reported to the Ecotech architect before any work commence. The

Ecotech architect before any work commence. T Architect's drawings and specifications overrule

- All construction work to comply with the international standards codes protection.
- The PV denotes permanent ventilation and mus provided above all doors and windows where indicate
- 6. All reinforced concrete works to be done according







DERAL REPUBLIC GOVERNMENT OF PUNT
SOMALIA STATE - GALKANYO NO
DISTRICT

SFF SOMALIA
Special Financing Facility

CONSULTANT:



#### ECOTECH LIMITED

D. Box 5527-00100.

1yu +254 712 388815

+254 701 838222 Info@ecotech.co.ke

l: Info@ecotech.co.ke www.ecotech.co.ke ion: Ecotech House, Woodlands Road, off Lenana Road. Nairobi - Kenya



STRUCTURAL 03

STRUCTURAL DETAILS 03

Scale: AS SHOWN


Date: JULY 2017
PREPARED BY: PETER MUTUGI


EVIEWED & APPROVED BY:


mars runer - rac at the


| Drawing No: | Project No: | 31371-553- | STRUCTURAL 03-11 | MOF/SFF/SERV/08 | Sheet No: |


#### **CONSERVANCY TANK DETAILS**

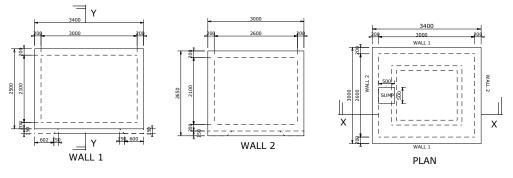


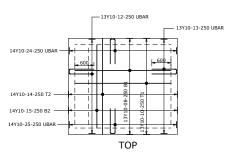


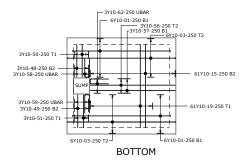

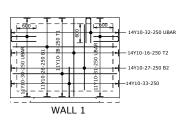

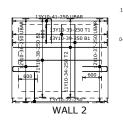

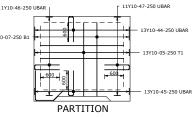

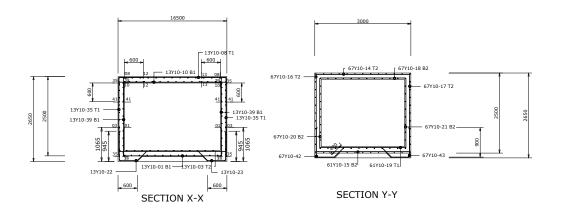

#### NOTES ON STRUCTURAL DETAILS

- These notes shall be deemed to apply to all structural drawings.
- The structural drawings shall be read in conjunction with the architectural drawings and in event of any discrepancies, the Engineer and the Architect shall be notified before proceeding with the work.
- All dimensions shall be verified by the Contractor and drawings shall not be scaled off.
- Concrete shall have 20mm maximum size of aggregates and shall be adequately vibrated and cured. Concrete grade shall be Class 25 unless otherwise stated by the Engineer.
- $\begin{tabular}{ll} 5. & Building concrete shall be $1:4:8$ mix and shall be \\ & 50mm thick unless otherwise stated. \\ \end{tabular}$
- 6. Building blocks shall be adequately bonded and set in 3:1 sand/cement mortar.
- Steel reinforcement shall be cold worked bars to B.S. 4461 ref. Y and Round Mild Bars to B.S. 4448 ref. R.
- 8. Unless otherwise stated, concrete covers shall be:
  - 50mm for foundations.
  - 40mm for columns
  - 20mm for slabs and staircases
  - 25mm for beams
- Contractor shall verify the dimensions given in the Bending Schedules before cutting and bending steel reinforcement.
- 10. These notes do not supersede the Specifications and the Contractor shall consult the Engineer in event of any contradictions.
- 11. Cube Tests shall be done for every concreting. Any concrete work that fails tests shall be demolished and redone at the cost of the Contractor.
- 12. Safe bearing pressure of soil is 150KN/m<sup>2</sup>
- $13. \ \ \, Structural timber shall be well-seasoned timber stress grade S3 cypress (B.S. 5268-2:2002) with \\ min. moisture content of 12\%.$

#### NOTE

 Inis drawing is protected under the copyrig and cannot be reused or reproduced in part or in

All dimensions are to be checked on site.
discrepancy in dimensions is to be reported to th
Footech architect before any work commence. T

chitect's drawings and specifications overrule as er.

The PV denotes permanent ventilation and mu

 The PV denotes permanent ventilation and must provided above all doors and windows where indicates

6. All reinforced concrete works to be done according

NO:	DATE:	DESCRIPTION:	1		
			]		
			l		
REVISIONS.					









CONSULTANT:



ECOTECH LIMITED

D. Box 5527-00100,

7-00100, ya +254 712 388815 +254 701 838222

nail: Info@cotech.co.ke
th: www.ecotech.co.ke
cation: Ecotech House, Woodlands Roa

Project Title:
DETAILED DESIGN FOR PROPOSED
ADMINISTRATION OFFICES IN
NORTH GALKAIO DISTRICT.
MUDUG REGION

STRUCTURAL 04

eet Content:

STRUCTURAL DETAILS 04


Date: JULY 2017
PREPARED BY: PETER MUTUGI


REVIEWED & APPROVED BY:

TEVIEWED & APPROVED BY:

ENG. AHMED KIRISH ENG.

 $12/19_{s}$ 

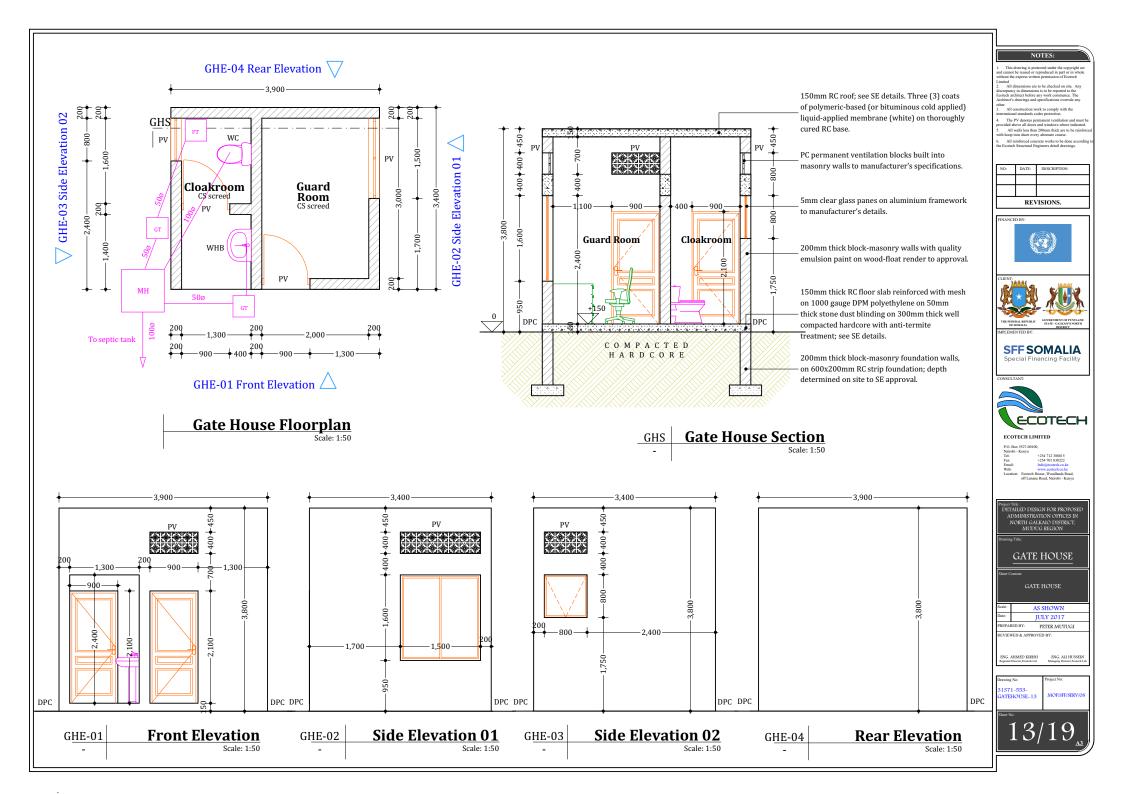

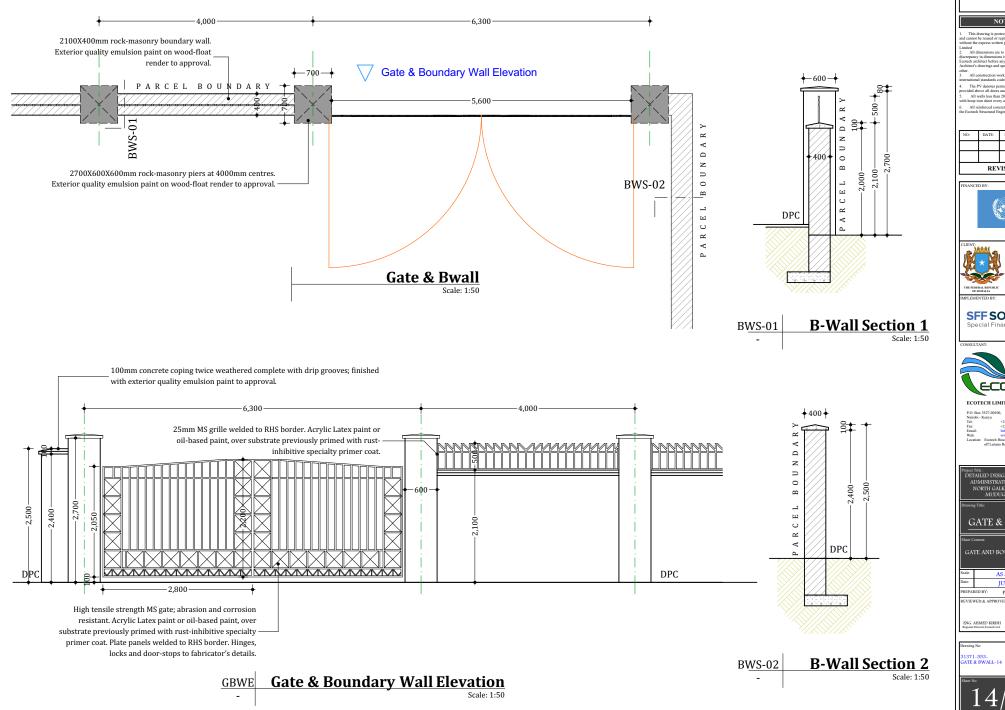

I	NO:	DATE:	DESCRIPTION:	
		REV	ISIONS.	











ETAILED DESIGN FOR PROPOSE NORTH GALKAIO DISTRICT. MUDUG REGION


GATE & B-WALL


GATE AND BOUNDARY WALL


JULY 2017 PETER MUTUGI


MOF/SFF/SERV/08

# GATE HOUSE FOUNDATION LAYOUT

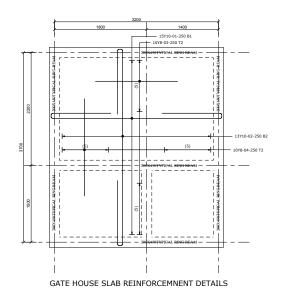

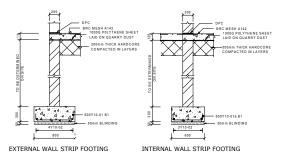

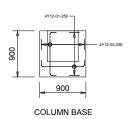


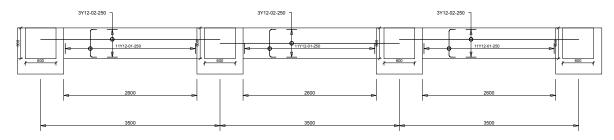

PLAN

#### NOTES ON STRUCTURAL DETAILS

- These notes shall be deemed to apply to all structural drawings.
- The structural drawings shall be read in conjunction with the architectural drawings and in event of any discrepancies, the Engineer and the Architect shall be notified before proceeding with the work.
- All dimensions shall be verified by the Contractor and drawings shall not be scaled off.
- Concrete shall have 20mm maximum size of aggregates and shall be adequately vibrated and cured. Concrete grade shall be Class 25 unless otherwise stated by the Engineer.
- 5. Building concrete shall be 1:4:8 mix and shall be 50mm thick unless otherwise stated.
- 6. Building blocks shall be adequately bonded and set in 3:1 sand/cement mortar.
- Steel reinforcement shall be cold worked bars to B.S. 4461 ref. Y and Round Mild Bars to B.S. 4448 ref. R.
- 8. Unless otherwise stated, concrete covers shall be:
  - 50mm for foundations.
  - 40mm for columns
  - 20mm for slabs and staircases
  - 25mm for beams
- Contractor shall verify the dimensions given in the Bending Schedules before cutting and bending steel reinforcement.
- These notes do not supersede the Specifications and the Contractor shall consult the Engineer in event of any contradictions.
- 11. Cube Tests shall be done for every concreting. Any concrete work that fails tests shall be demolished and redone at the cost of the Contractor.
- 12. Safe bearing pressure of soil is 150KN/m<sup>2</sup>
- Structural timber shall be well-seasoned timber stress grade S3 cypress (B.S. 5268-2:2002) with min. moisture content of 12%.

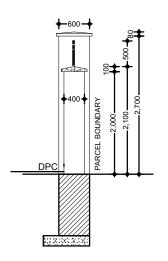

BOUNDARY WALL ELEVATION

#### NOTES

 This drawing is protected under the copyr and cannot be reused or reproduced in part or in

Limited

2. All dimensions are to be checked on site. Any discrepancy in dimensions is to be reported to the Ecotech architect before any work commence. The

Ecotech architect before any work commence. 
Architect's drawings and specifications overrule

- ternational standards codes protection.
- The PV denotes permanent ventilation and must be provided above all doors and windows where indicated.
   All walls less than 200mm thick are to be reinforwith hoop iron sheet every alternate course.
- All reinforced concrete works to be done according
  the Ecotoch Structural Economy detail drawings

NO:	DATE:	DESCRIPTION:
	<b>†</b>	
1		
-		
ıl	REVISIONS.	









CONSULTANT:



#### ECOTECH LIMITED

D. Box 5527-00100, iirobi - Kenya

+254 712 388815 +254 701 838222 il: Info@ecotech.co.ke

Project Title:

DETAILED DESIGN FOR PROPOSED

ADMINISTRATION OFFICES IN

NORTH GALKAIO DISTRICT,

MUDUG REGION

Drawing Title:

GH STRUCTURAL

Sheet Content:

GATE HOUSE

STRUCTURAL DETAILS

Scale: AS SHOWN

Date: JULY 2017
PREPARED BY: PETER MUTUGI


REVIEWED & APPROVED BY:

AHMED KIRISH ENG. ALI HUSS


Drawing No: Project No: 31371-553-GH STRUCTURAL-15 MOF/SFF/SERV/08

 $15/19_{4}$ 


#### SEPTIC TANK DETAILS

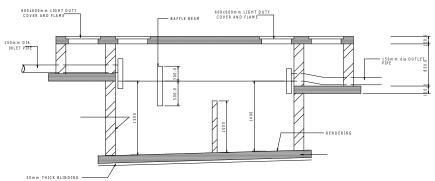


SECTION 2 - 2

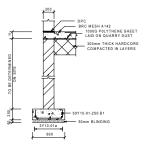

EXTERNAL WALL STRIP FOOTING

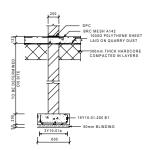


INTERNAL WALL STRIP FOOTING

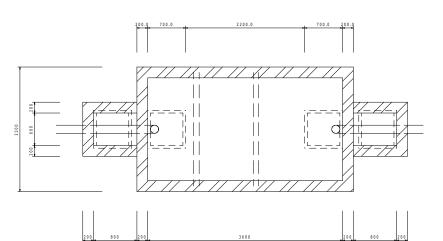

**ROOF LAYOUT** 

# 00x600mm LIGHT DUTY COVER AND FLAME - 150mm thk BASE SLAB ELEVATION SECTION 1 - 1

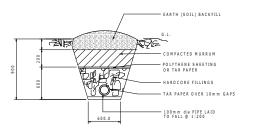

FRENCH DRAIN

# 2200.0 700.0

TOP SLAB REINFOREMENT

#### NOTES ON STRUCTURAL DETAILS

- 1. These notes shall be deemed to apply to all structural drawings.
- 2. The structural drawings shall be read in conjunction with the architectural drawings and in event of any discrepancies, the Engineer and the Architect shall be notified before proceeding with the work.
- 3. All dimensions shall be verified by the Contractor and drawings shall not be scaled off.
- 4. Concrete shall have 20mm maximum size of aggregates and shall be adequately vibrated and cured. Concrete grade shall be Class 25 unless otherwise stated by the Engineer.
- 5. Building concrete shall be 1:4:8 mix and shall be 50mm thick unless otherwise stated.
- 6. Building blocks shall be adequately bonded and set in 3:1 sand/cement mortar.
- 7. Steel reinforcement shall be cold worked bars to B.S. 4461 ref. Y and Round Mild Bars to B.S. 4448 ref. R.
- 8. Unless otherwise stated, concrete covers shall be:
  - 50mm for foundations.
  - 40mm for columns
  - 20mm for slabs and staircases
  - 25mm for beams
- Contractor shall verify the dimensions given in the Bending Schedules before cutting and bending steel reinforcement.
- 10. These notes do not supersede the Specifications and the Contractor shall consult the Engineer in event of any contradictions.
- 11. Cube Tests shall be done for every concreting. Any concrete work that fails tests shall be demolished and redone at the cost of the Contractor.
- 12. Safe bearing pressure of soil is 150KN/m<sup>2</sup>
- 13. Structural timber shall be well-seasoned timber stress grade S3 cypress (B.S. 5268-2:2002) with min, moisture content of 12%.



All dimensions are to be checked on site. An

All walls less than 200mm thick are to be hoop iron sheet every alternate course.













ECOTECH LIMITED


ETAILED DESIGN FOR PROPOSEI NORTH GALKAIO DISTRICT. MUDUG REGION

SEPTIC TANK


JULY 2017 PETER MUTUGI

31371-553-SEPTIC TANK-1 MOF/SFF/SFRV/O

SYMBOL	MEANING
ф	CEILING MOUNTED LIGHT FIXTURE.
	CEILING MOUNTED
Ψ	LIGHT FIXTURE (PENDANT)
9	WALL MOUNTED LIGHT FIXTURE
<b>©</b>	RECESSED SPOT LIGHT
	FLUORESCENT LIGHT FIXTURE
	FLUORESCENT LIGHT FIXTURE UNDER FALSE CEILING
	WIRING CONNECTION
iiss	FLUORESCENT LIGHT FIXTURE WITH SHAVER SOCKET & LOCALISED SWITCH
⊢— s	FLUORESCENT LIGHT FIXTURE WITH LOCALISED SWITCH
φ	SINGLE PLEX RECEPTACLE
<del>=</del>	DUPLEX RECEPTACLE
-	SPECIAL RECEPTACLE & OUTLET (WITH PILOT LIGHT)
<b>₩</b>	WATER PROOF RECEPTACLE (SINGLE)
	CONSUMER UNIT
M	TELEPHONE/TV JACK
<b>Æ</b>	ALARM KEYPAD
•	DOORBELL PUSH BUTTON
	DOORBELL TRANSFORMER
S3	3 gang switch
S2	2 gang switch
S	Single pole switch
₩	Flood lamp

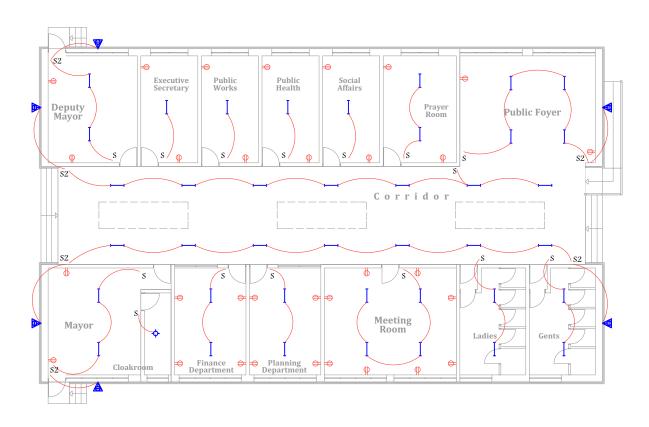

#### **Main Block Electrical** Scale: 1:150

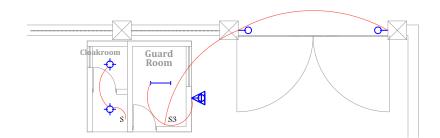

**GH Electrical** Scale: 1:100

The PV denotes permanent ventilation and must b wided above all doors and windows where indicated. All walls less than 200mm thick are to be reinforce the hoop iron sheet every alternate course.

- 1			
	NO:	DATE:	DESCRIPTION:
		REV	VISIONS.





**SFF SOMALIA** 



ECOTECH LIMITED

P.O. Box 5527-00100,
Nairobi - Kenya
Tel: +254 712 388815
Fax: +254 701 838222
Email: info@cochech.co.ke
Web: www.costech.co.ke
Location: Ecotech House, Woodlands Road
off Leman Road, Nairobi - Keny



#### ELECTRICAL


Scale:	AS SHOWN
Date:	JULY 2017

PREPARED BY: PETER MUTUGI


REVIEWED & APPROVED BY:

31371-553-ELECTRICAL-17

MOF/SFF/SERV/08

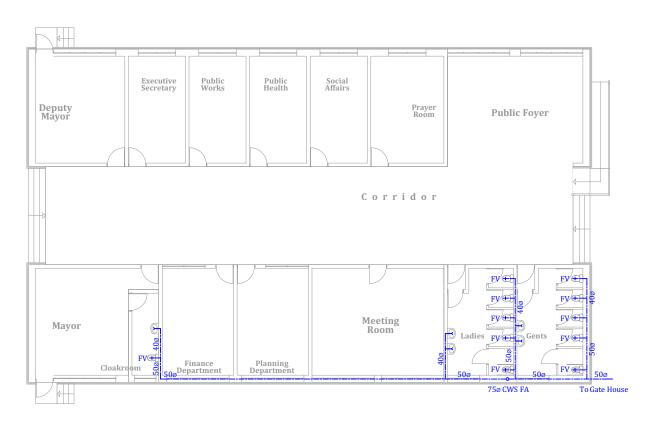

### Main Block Plumbing Scale: 1:150

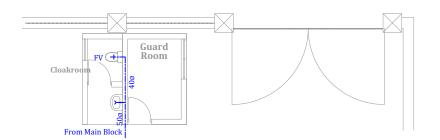

GH Plumbing
Scale: 1:100

#### **LEGEND**

TA ...... TO ABOVE
TB ...... TO BELOW
FA ..... FROM ABOVE
FB ..... FROM BELOW
RM ..... RISING MAIN
HL ..... HIGH LEVEL
RE ..... RODDING EYE
MH ..... MAN HOLE
GT .... GULLY TRAP
SVP ..... STACK VENT PIPE
FT .... FLOOR TRAP
FV ..... FLOAT VALVE
CWS ..... COLD WATER SUPPLY

#### NOTES

and cannot be reused or reproduced in part or in

All dimensions are to be checked on site.
 discrepancy in dimensions is to be reported to the
Ecotech architect before any work commence. Ti

other.

3. All construction work to comply with

The PV denotes permanent ventilation and must be vided above all doors and windows where indicated.

All walls less than 200mm thick are to be reinfo with hoop iron sheet every alternate course.

NO. DATE DESCRIPTION

REVISIONS.





RIPUBLIC GOVERNMENT OF PUNT
STATE - GALKATYO NO

LEMENTED BY:

SFF SOMALIA
Special Financing Facility

CONSULTANT:



ECOTECH LIMITED

Box 5527-00100,

7-00100, ya +254 712 388815 +254 701 838222 Info@ecotech.co.ke

Info@ecotech.co.ke www.ecotech.co.ke on: Ecotech House, Woodlands Road, off Lenana Road, Nairobi - Kenya

Project Tale:

DETAILED DESIGN FOR PROPOSED
ADMINISTRATION OFFICES IN
NORTH GALKAIO DISTRICT:
MUDUG REGION

Durning Title:

PLUMBING

PLUMBING LAYOUT

Scale: AS SHOWN

Date: JULY 2017
PREPARED BY: PETER MUTUGI

EVIEWED & APPROVED BY:

EVIEWED & APPROVED BY:

G. AHMED KIRISH ENG. AI


Drawing No: 31371-553-PLUMBING-18

MOF/SFF/SERV/08

18/19



Front/Side view

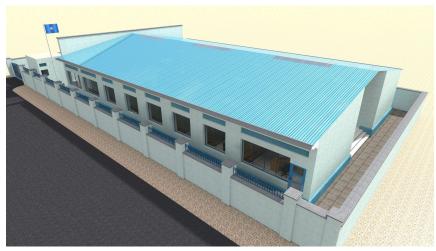

Side view



Interior view



Rear view

NO:	DATE:	DESCRIPTION:
_	+	
	1	











#### PERSPECTIVES

PREPARED BY: PETER MUTUGI

31371-553-PERSPECTIVES-19 19/19